


TYPICAL SECTION
1" = 5'

- NOTES:
- (A) Midwest Guardrail System, see "ROADWAY PLANS"
 - (B) Paint "Bridge No. 21C-0143"
 - (C) Paint "Dry Creek Road Bridge Over Dry Creek"
 - (D) Rock Slope Protection, see "ROADWAY PLANS"
 - (E) Minimum Structure depth is 4'-3". Structure depth at BB & EB is 4'-6 1/8"

- LEGEND:
- Indicates Bridge Removal
 - Indicates Potential Contractor Staging Area
 - Indicates Traffic Direction
 - Indicates Direction of Flow

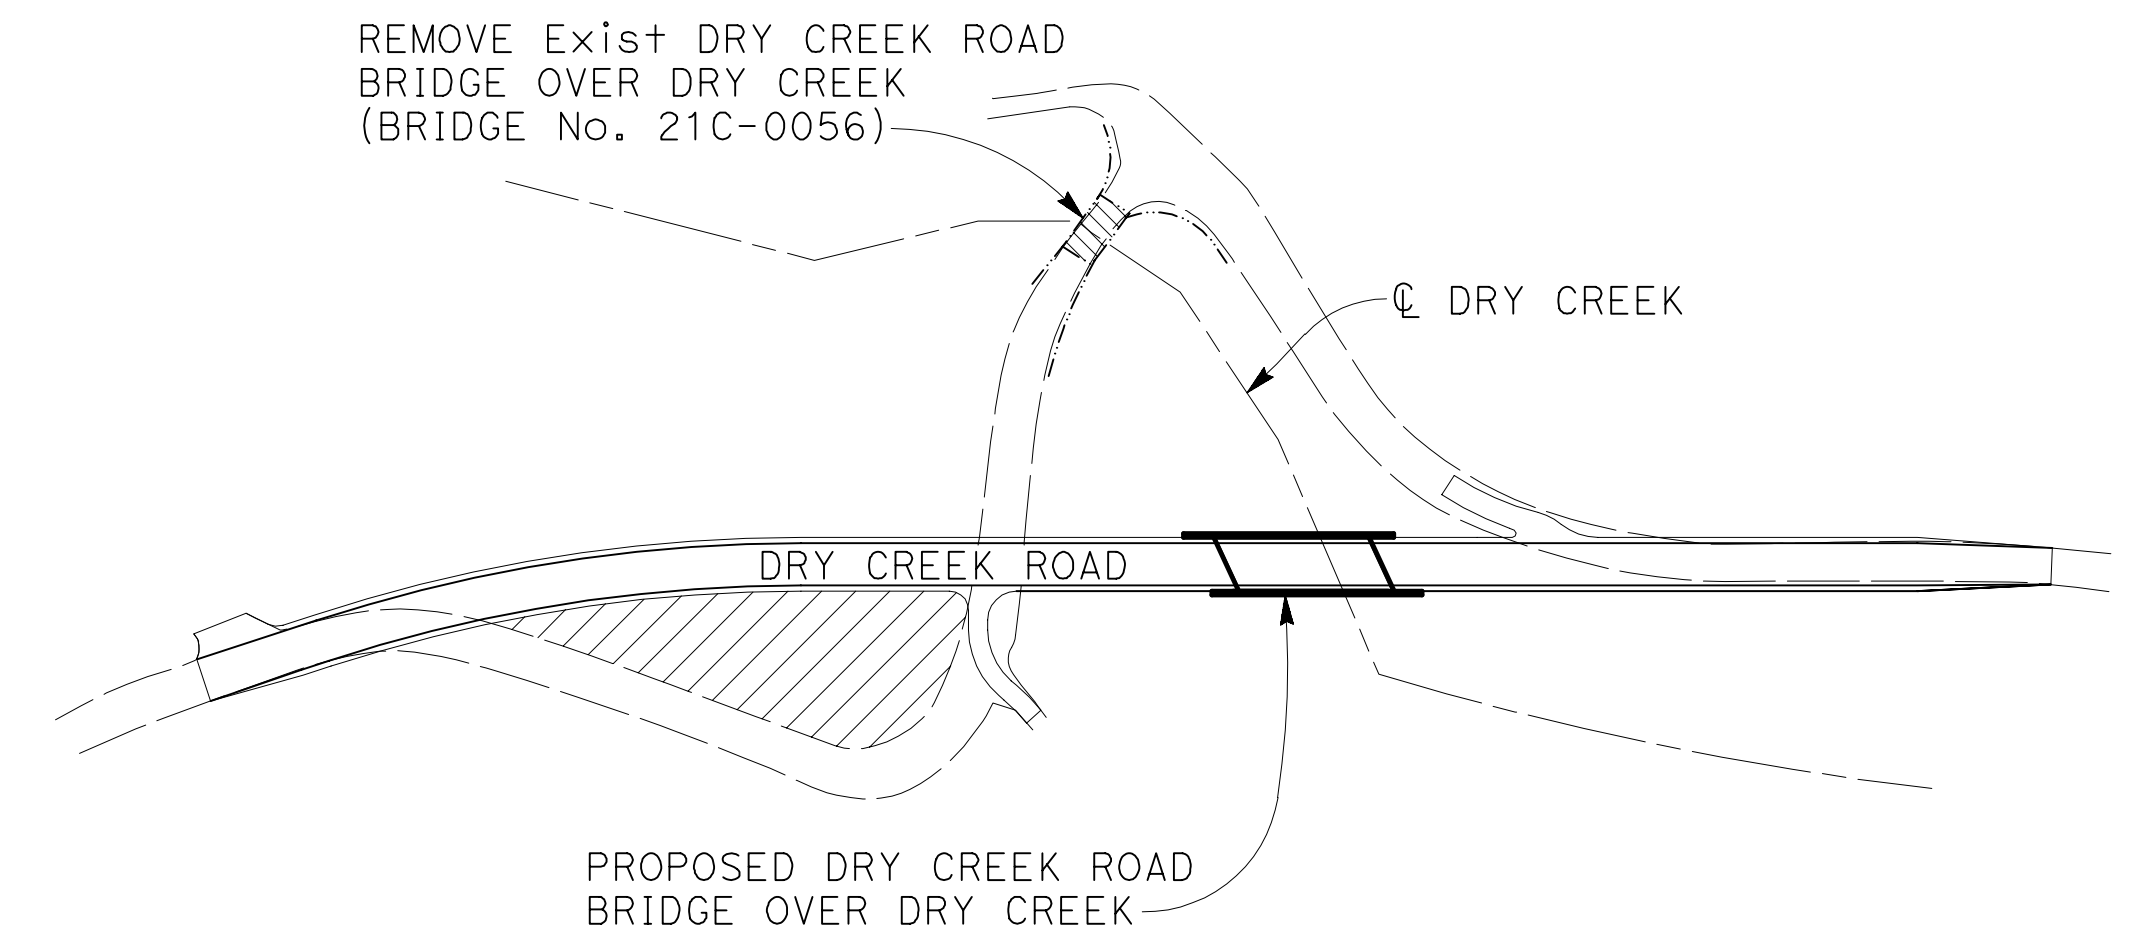

SITE PLAN
NO SCALE

PLAN CHECK SET/NOT FOR CONSTRUCTION (5/5/20)

NOTE:
The contractor must verify all controlling field dimensions before ordering or fabricating any material.

REV	DESCRIPTION	DATE



BIGGS CARDOSA ASSOCIATES INC
STRUCTURAL ENGINEERS

865 The Alameda
San Jose, California 95128
408-296-5515

DATE: 05/31/18

SCALE: AS SHOWN

FILE NAME: 2015261SA-S1.dwg

SURVEY NOTE:

DESIGN: NBP

DRAWN: SMH

CHKD: JAA

SHEET TITLE	
GENERAL PLAN	
PROJECT TITLE	
DRY CREEK ROAD BRIDGE OVER DRY CREEK, BRIDGE No. 21C-0143, RDS 15-22, BRLS-5921(061)	
S1	35 OF 51
SHEET OF	

2015261A-S1